

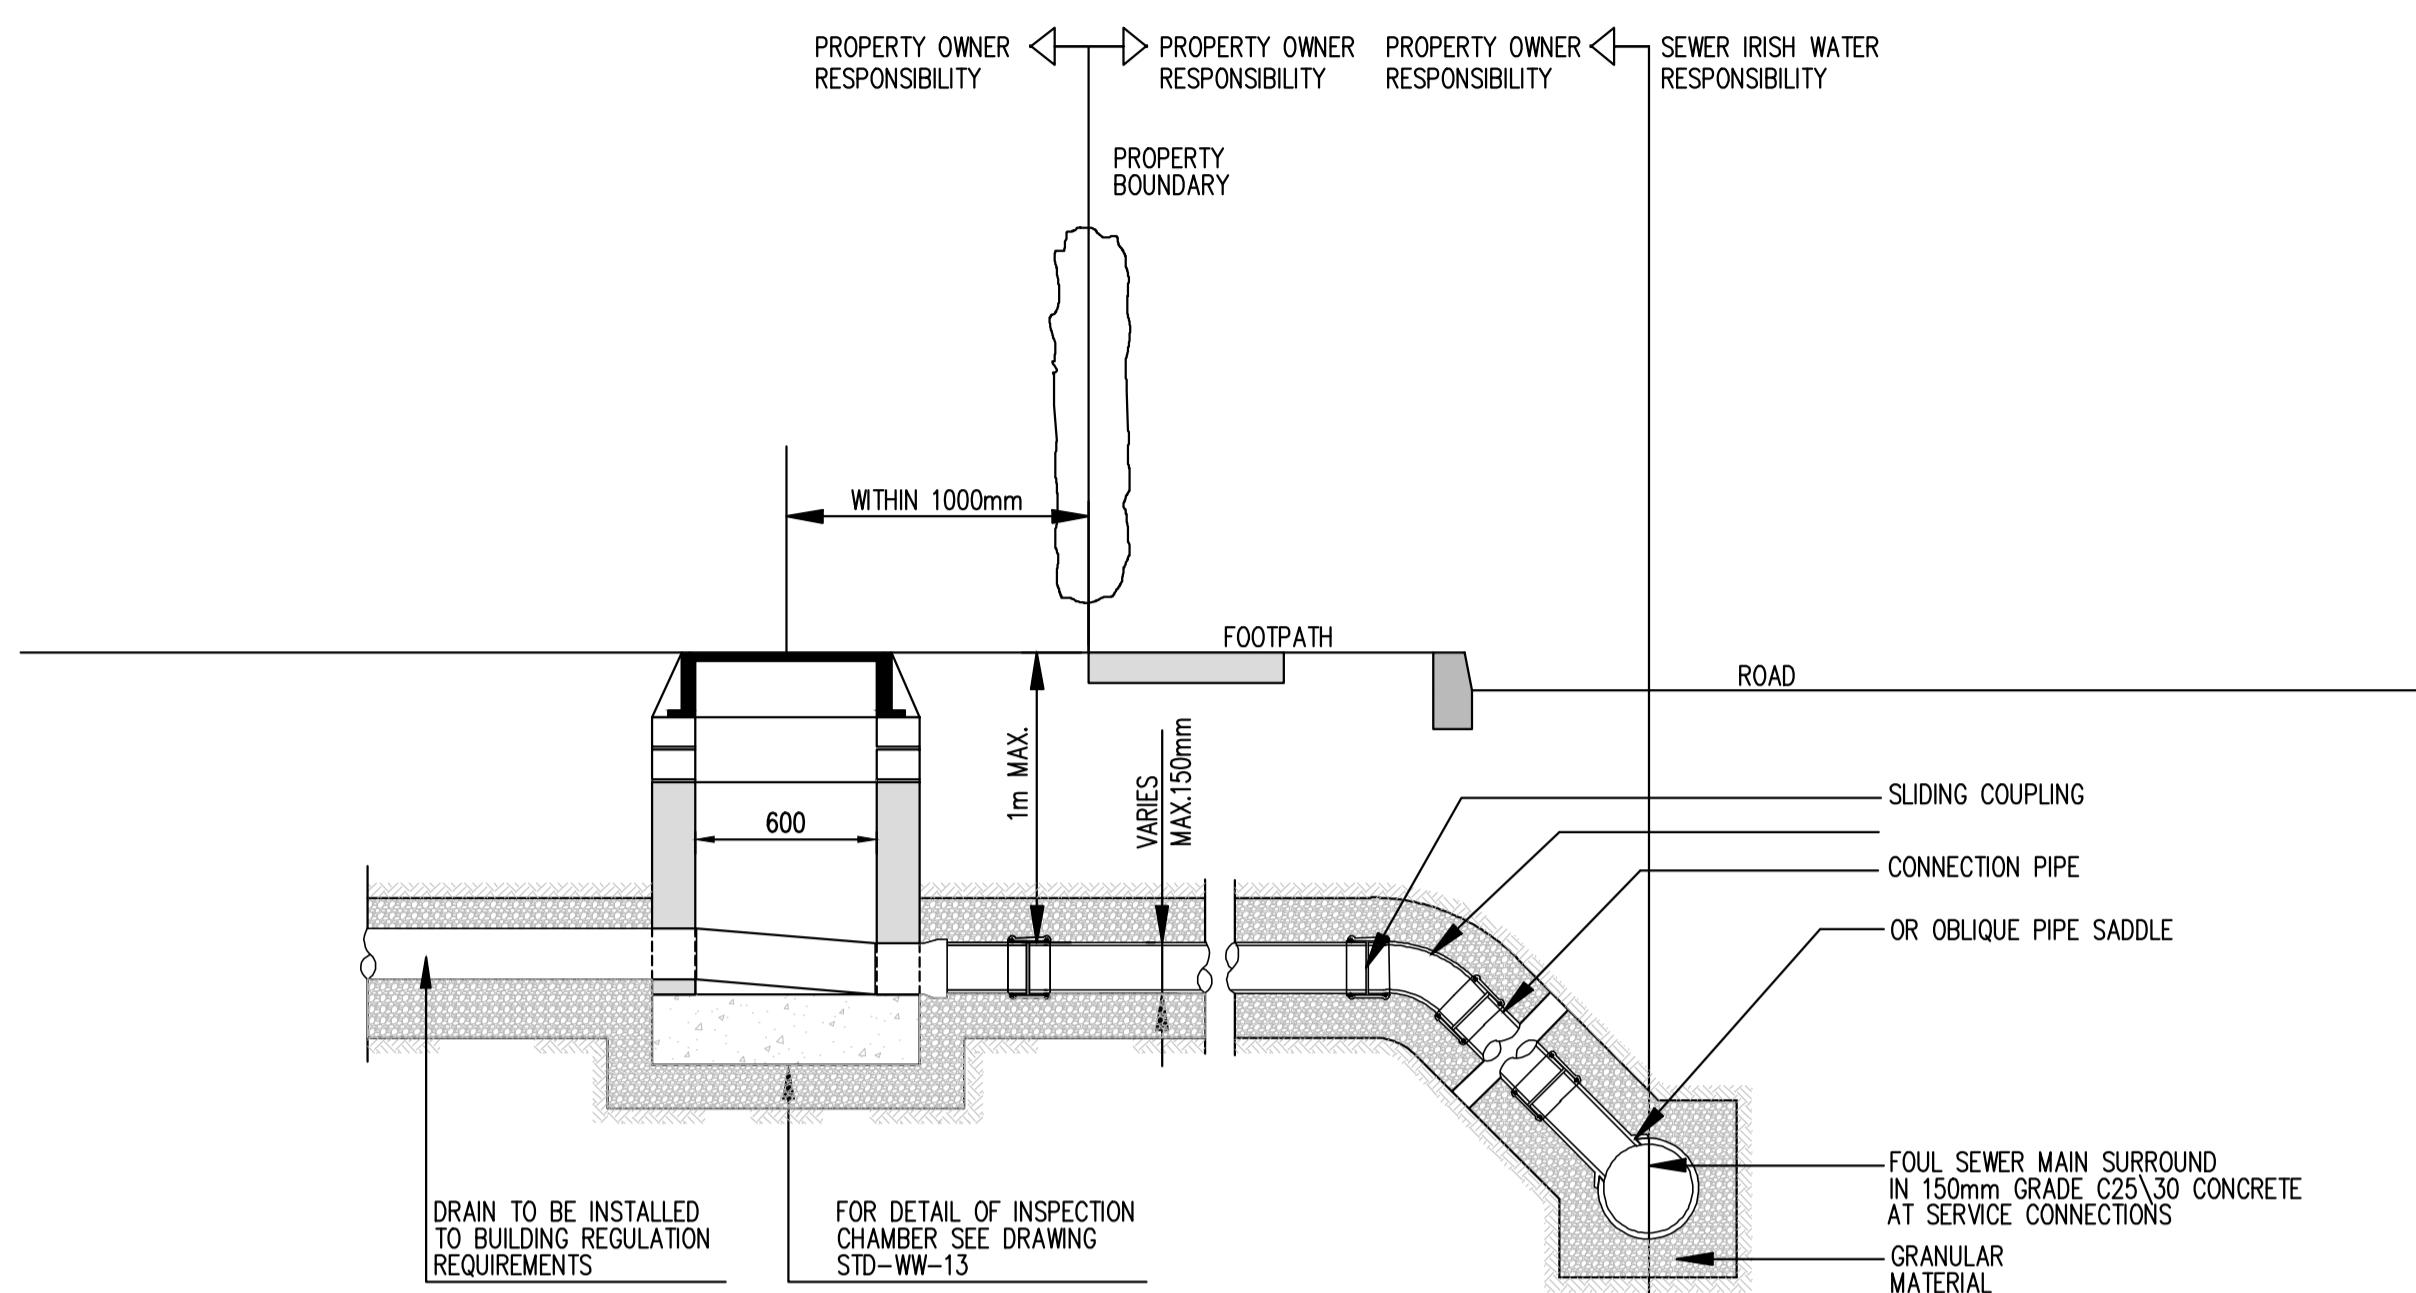


NOTES:

1. DO NOT SCALE. USE FIGURED DIMENSIONS ONLY.
2. THIS DRAWING IS TO BE READ IN CONJUNCTION WITH ALL OTHER RELEVANT ARCHITECTURAL AND ENGINEERING DRAWINGS.

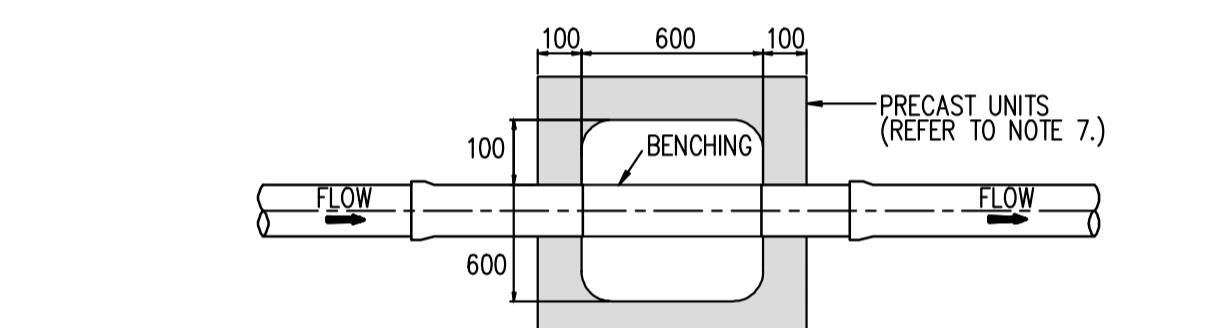


1. ALL DIMENSIONS IN MILLIMETRES (mm) UNLESS NOTED OTHERWISE.
2. AN INSPECTION CHAMBER SHOULD BE LOCATED AT OR WITHIN 1m OF THE PROPERTY BOUNDARY AT THE UPSTREAM END OF EACH SERVICE CONNECTION ON THE PRIVATE SIDE OF THE CURTILAGE, IF PRACTICABLE.
3. ANY PIPE AND ASSOCIATED ACCESS UPSTREAM OF THE POINT OF CONNECTION TO A PUBLIC SEWER IS A PRIVATE DRAIN AND SHOULD BE CONSTRUCTED IN ACCORDANCE WITH THE BUILDING REGULATIONS.
4. ACCESS POINTS SHOULD BE LOCATED SO THAT THEY ARE ACCESSIBLE AND APPARENT TO THE MAINTAINER AT ALL TIMES FOR USE. THEY SHOULD AVOID REAR GARDENS OR ENCLOSED LOCATIONS AND THEY SHOULD NEVER BE OVERLAIN WITH SURFACE DRESSING, TOPSOIL, ETC.
5. COVERS AND FRAMES SHALL BE SUITABLE FOR ROAD AND TRAFFIC CONDITIONS SUBJECT TO APPROVAL FROM IRISH WATER.
6. 200mm ALL AROUND, 100mm DEEP CONCRETE PLINTH WITH PROTECTIVE STAINLESS STEEL METAL BAND AROUND COVERS IN GREEN AREAS.
7. PROPRIETARY PREFABRICATED CHAMBER UNITS MAY ALSO BE USED, SUBJECT TO APPROVAL FROM IRISH WATER.
8. CONCRETE CHAMBERS SHALL BE SURROUNDED BY A MINIMUM OF 150mm COMPACTED CLAUSE 804 MATERIAL AS PER STD-WW-07.
9. ALL CHAMBERS TO BE CHECKED FOR UPLIFT BY THE DEVELOPER BASED ON GROUND CONDITIONS WITHIN THE SITE. SHOULD ANTI FLOATATION MEASURES BE REQUIRED THEY SHALL BE SUBJECT TO APPROVAL FROM IRISH WATER.

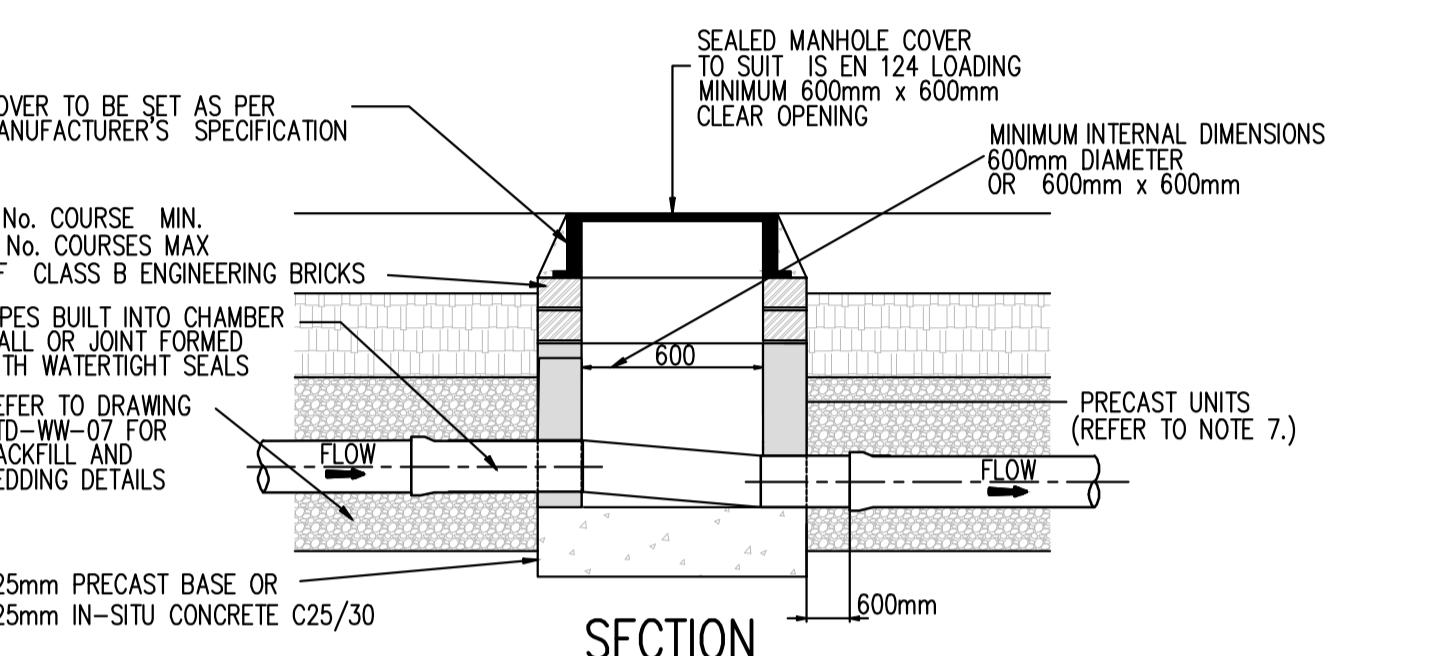

IRISH WATER FINAL INSPECTION CHAMBER DETAIL

PIPE SIZE (mm)	GRADIENT
100	1 : 60
150 TO 225	1 : 150 MINIMUM



DRAIN AND SERVICE CONNECTION PIPEWORK

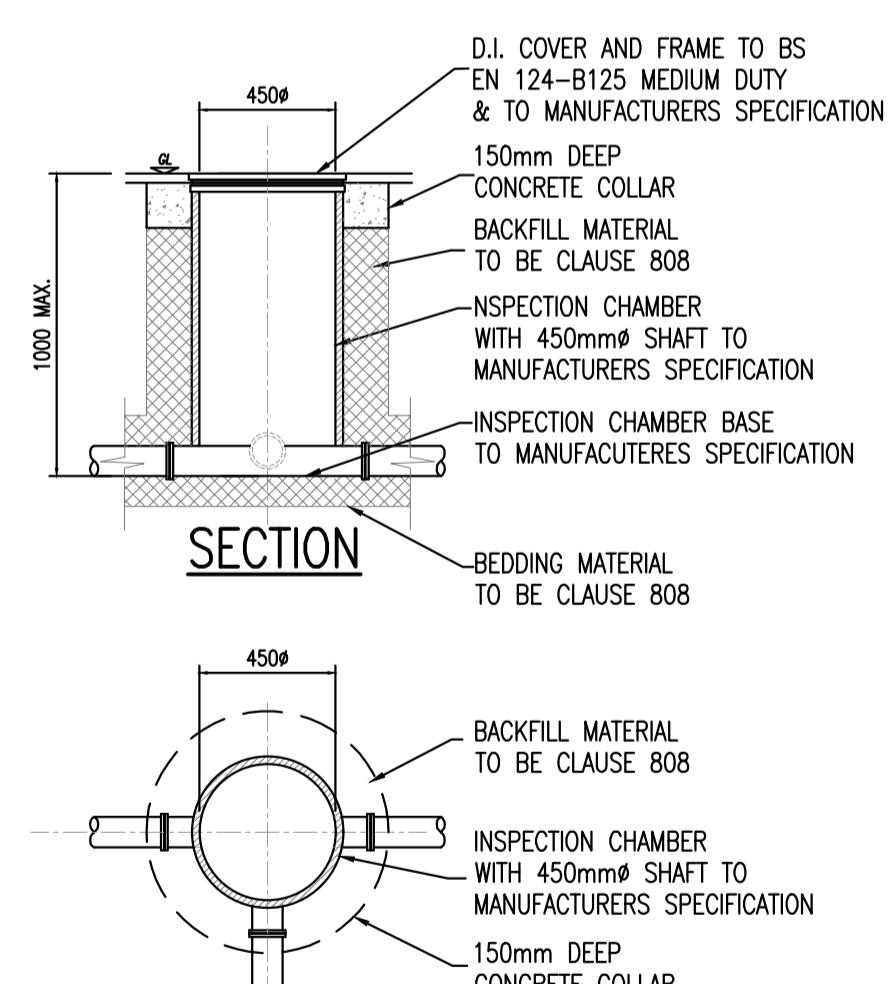

PLAN

CIRCULAR INSPECTION CHAMBER WHERE
INVERT IS 1m OR LESS BUILDING
REGULATIONS TGD SECTION H TABLE 9

SCALE 1:25

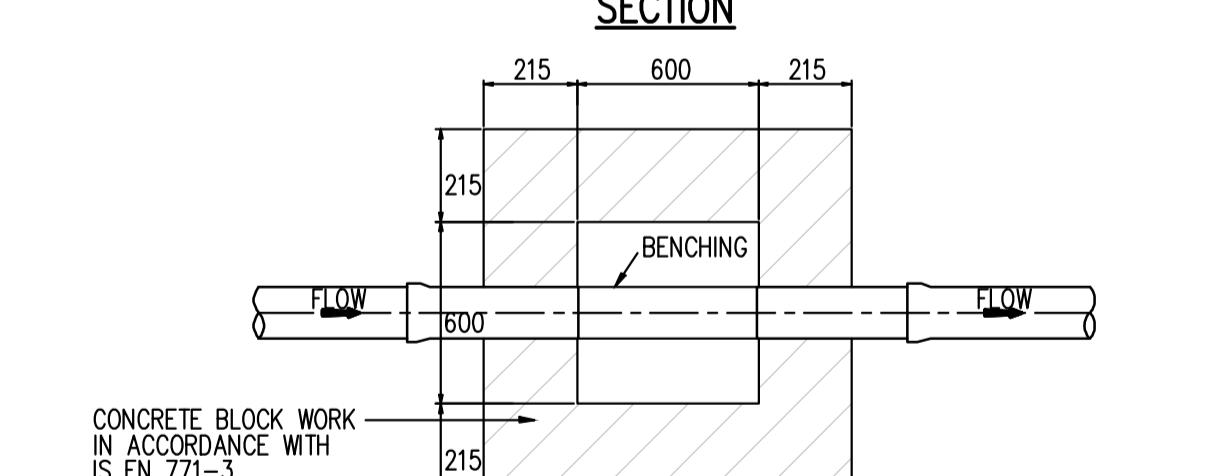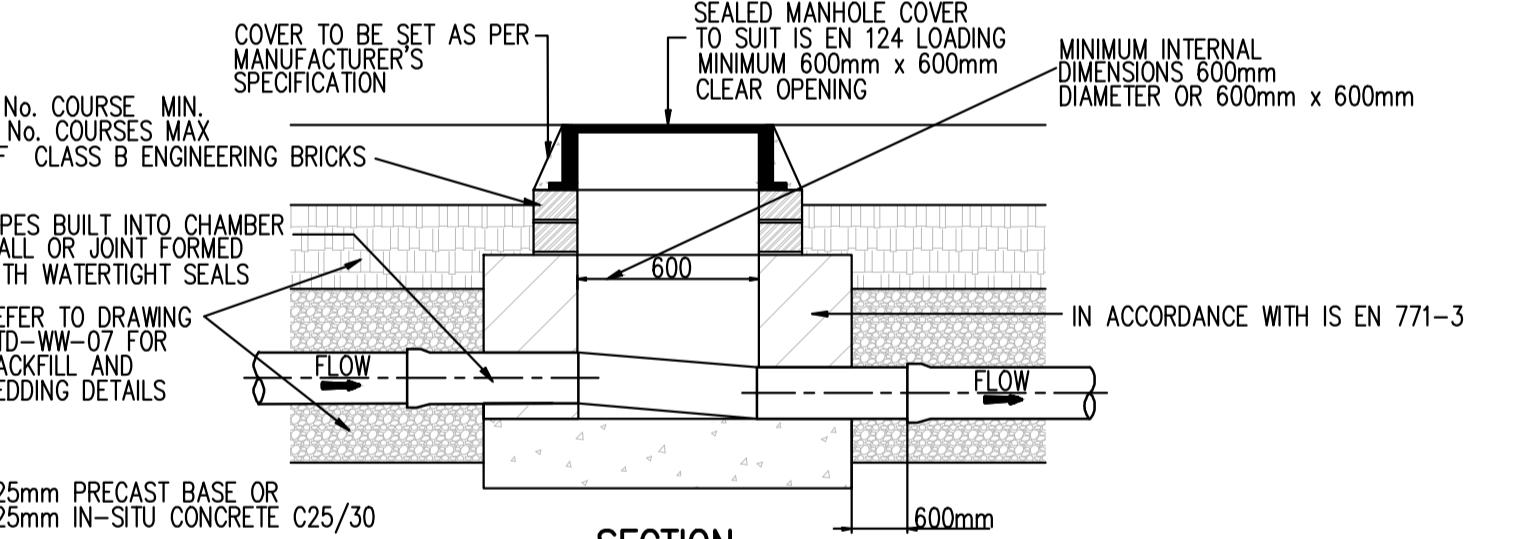

FLOOR PLAN
INSPECTION CHAMBER
(BLOCK WORK CONSTRUCTION)

PRIVATE SIDE INSPECTION CHAMBER

P1	16/04/25	LRD STAGE 3 PLANNING SUBMISSION	GB	EC
Amendments				
Project				
WOODTOWN, BALLYCULLEN				
Title				
PRIVATE FOUL DRAINAGE DETAILS				
Client				
LAGAN HOMES BALLYCULLEN LIMITED				
				
BLOCK S, EASTPOINT BUSINESS PARK, ALFIE BYRNE ROAD, DUBLIN D03 H3F4 IRELAND. Tel: (01) 694 8900 Email: info@waterman-moylan.ie www.waterman-moylan.ie				

Status				
PLANNING				
Designed By	EC	Approved	JG	Waterman Ref
Drawn By	GB	Date	APRIL 2025	24-007
Scales @ A1				
AS SHOWN				
Project - Originator - Volume - Level - Type - Role - Number				
Revision				
BYCN- WM - 00 -XX-DR- C -P1232				
P1				